

C:\Users\Matthew\Documents\SL03-Plan_Matthew-C-JWP.rvt 24/09/2020 12:08:56 PM

DO NOT SCALE DRAWINGS


FIGURED DIMENSIONS TAKE PRECEDENCE.

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Revision	Revision Date	Revision Description	Issued by
T1	2020.09.24	TENDER ISSUE	

FLOOR PLAN - NORTH EAST
SCALE: 1 : 50

Keynote Legend Copy 1		Keynote Legend Copy 1		Keynote Legend Copy 1		Keynote Legend Copy 1		Keynote Legend Copy 1	
Key Value	Keynote Text	Key Value	Keynote Text	Key Value	Keynote Text	Key Value	Keynote Text	Key Value	Keynote Text
BF1	BRICK FACE-TYPE 1	DP4	DOWNPIPE-TYPE 4	INS4	INSULATION-ACOUSTIC WALL	PSH	PLASTER SHADOW LINE MOULD	TIM1	TIMBER-TYPE 1
BF2	BRICK FACE-TYPE 2	DP5	DOWNPIPE-TYPE 5	MC1	METAL SOFFIT CLADDING-TYPE 1	PSS	PLASTER SQUARE SET MOULD	TR1	TIMBER SKIRTING
BS1	BRICK SILL-TYPE 1	DPC	DAMP PROOF COURSE	MCL1	METAL CLADDING-TYPE 1	P11	PAINT FINISH 1	TSK	TIMBER SKIRTING
CJ	CONTROL JOINT	DPS	DOWNPIPE-SPREADER	MCL2	METAL CLADDING-TYPE 2	P12	PAINT FINISH 2	TSR1	TRANSLUCENT SHEETING ROOF-TYPE 1
CMS	CONCRETE MOWING STRIP	EM	ENTRY MAT	MCL3	METAL CLADDING-TYPE 3	P13	PAINT FINISH 3	TV	TELEVISION
COL	COLUMN	FCC1	FIBRE CEMENT SHEET CLADDING-TYPE 1	MF1	METAL FOLDED FLASHING	P14	PAINT FINISH 4	TWC1	TIMBER WALL CLADDING-TYPE 1
CON	CONCRETE SLAB	FCC2	FIBRE CEMENT SHEET CLADDING-TYPE 2	MF2	METAL FOLDED FLASHING-TYPE 1	P16	PAINT FINISH 6	TWC2	TIMBER WALL CLADDING-TYPE 2
CPS	CONCRETE PAVING SLAB	FES	FEATHER EDGED SKIRTING	MR	MIRROR	RS1	RESILIENT SHEET-TYPE 1	VBC	VITRAPANEL CLADDING-TYPE 1
CPT1	CARPET-TYPE 1	GBR	GRAB RAIL	MF11	METAL FOLDED FLASHING-TYPE 1	RS2	RESILIENT SHEET-TYPE 2	VBC1	VITRAPANEL CLADDING-TYPE 1
CVS	COVERED VINYL SKIRTING	GR2	GRAB RAIL-TYPE 2	MF22	METAL FOLDED FLASHING-TYPE 2	RS3	RESILIENT SHEET-TYPE 3	VBC2	VITRAPANEL CLADDING-TYPE 2
DISP	DISPENSER	GUT1	GUTTER-TYPE 1	MR1	METAL ROOFING-TYPE 1	RS4	RESILIENT SHEET-TYPE 4	VBC3	VITRAPANEL CLADDING-TYPE 3
DISP2	DISPENSER PAPER	GUT2	GUTTER-TYPE 2	MR2	METAL ROOFING-TYPE 2	RS5	RESILIENT SHEET-TYPE 5	VBC4	VITRAPANEL CLADDING-TYPE 4
DISP3	DISPENSER PAPER	GUT3	GUTTER-TYPE 3	MR3	METAL ROOFING-TYPE 3	RWH	RAIN WATER HEAD	VBC5	VITRAPANEL CLADDING-TYPE 5
DP	DOWNPIPE	HR1	HAND RAIL-TYPE 1	PB1	PLASTERBOARD-TYPE 1	SAR	SARKING	VBC6	VITRAPANEL CLADDING-TYPE 6
DP1	DOWNPIPE-TYPE 1	HWS	HOT WATER SERVICE	PB3	PLASTERBOARD-TYPE 3	SF	STRUCTURAL FRAMING	WAL	WET AREA LINING
DP2	DOWNPIPE-TYPE 2	INS1	INSULATION-THERMAL WALL	PIN	PIN BOARD	TIL1	TILES-TYPE 1	WB	WHITE BOARD
DP3	DOWNPIPE-TYPE 3	INS2	INSULATION-THERMAL CEILING	PIN1	PIN BOARD-TYPE 1	TIL3	TILES-TYPE 3		
				PLY1	PLY-LINING-TYPE 1	TIL4	TILES-TYPE 4		
						TIM	TIMBER		

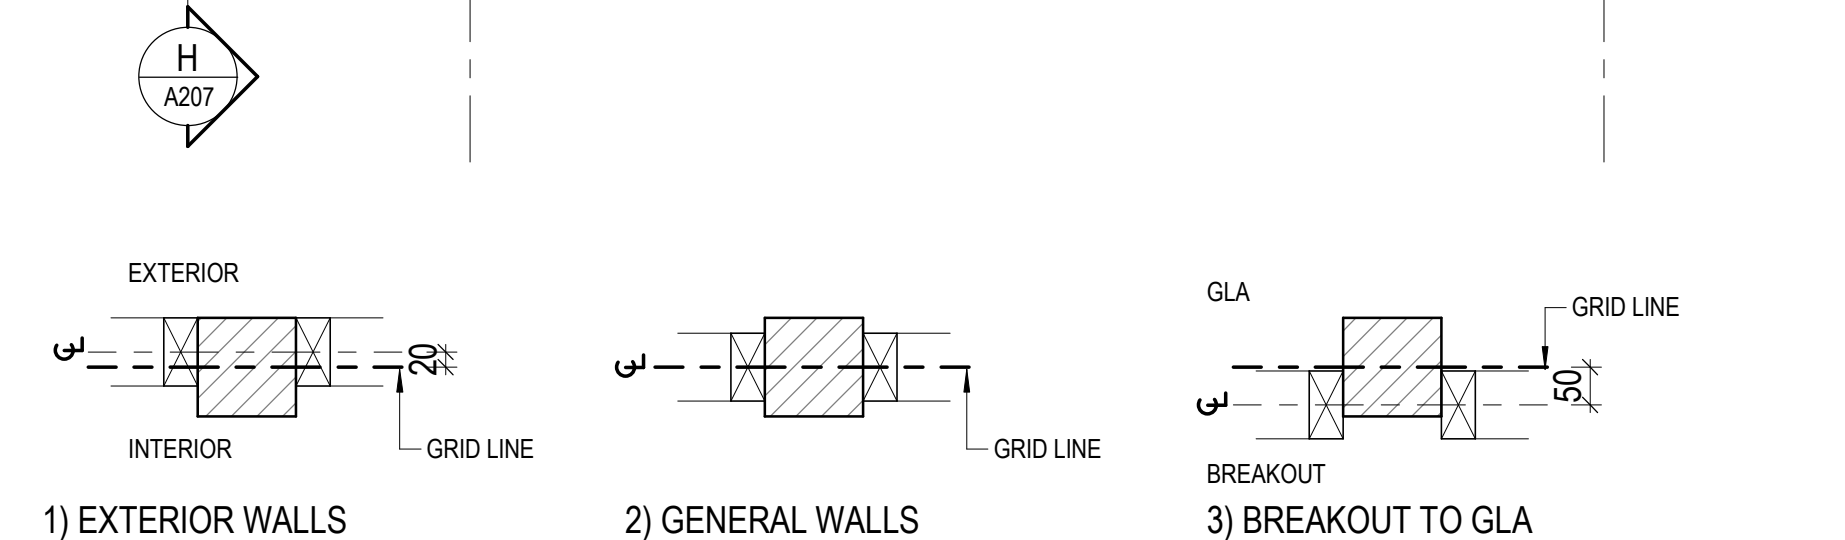


STUD AND TIMBER COLUMN SETOUTS
SCALE: 1 : 10

WALL TYPE LEGEND

- 90mm STAGGERED STUD WALL - ACOUSTIC INSULATION (INS4) 70mm TIMBER STUD WALL
- 140mm STUD + INS1
- CORRUGATED METAL CLADDING 35mm METAL FURRING CHANNEL + SARKING 90mmx140mm TIMBER STUD + INS1
- PERFORATED METAL CLADDING 40mm SHS CHANNEL 6mm FIBRE CEMENT SHEET + SARKING 90mm TIMBER STUD + INS1
- VITRAPANEL CLADDING 35mm METAL FURRING CHANNEL + SARKING 90mm TIMBER STUD + INS1
- 250 FACE BRICK 110mm BRICK VENEER 50mm AIR GAP SARKING 90mmx140mm TIMBER STUD + INS1
- 250mm PRECAST CONCRETE 50mm AIR GAP SARKING 90mm TIMBER STUD + INS1
- 110mm FACE BRICK

NOTE:
GENERAL DIMENSIONS ARE FROM CENTRE OF COLUMNS UNLESS OTHERWISE STATED
BUILDER TO PROVIDE NOGGINGS FOR FIXING POINTS
BUILDER TO INSTALL BRACKETS FOR TV'S

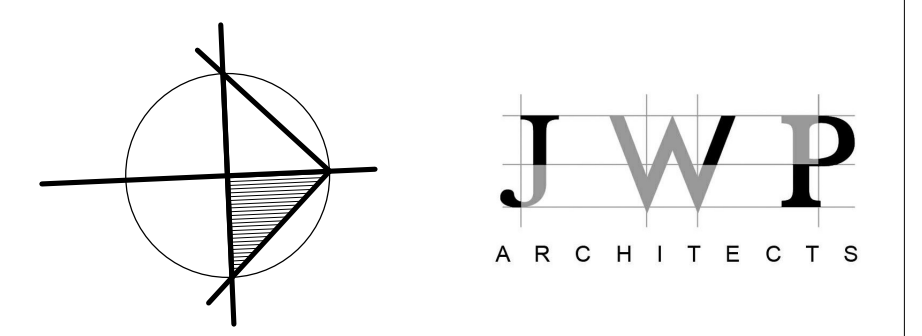

ST LUKE'S PRIMARY SCHOOL, SHEPPARTON
PROPOSED CLASSROOMS

FLOOR PLAN - NORTH EAST

Drawing No	A109	T1
Status	TENDER	Scale shown for A1
7 HIGH STREET WOODONGA VIC 3690 - Ph 02 65246888 - EMAIL MAIL@JWPARCHITECTS.COM.AU www.jwparchitects.com.au		